

FLOOR AREAS

TOTAL INDUSTRY AREA
TOTAL OFFICE/MEZZANINE = 849.2m² = 77.1m² FUTURE OFFICE = 61.1m²

SITE ANALYSIS

TOTAL BUILDING AREA = 1111.9m² SITE AREA = 5050.0m² SITE COVERAGE = 21.9%

CAR PARKING

1 CARSPACE PER 100m² GROSS FLOOR AREA TOTAL CARSPACES REQUIRED = 11.1 (12)
TOTAL CARSPACES PROVIDED = 12

BICYCLE PARKING

1 BICYCLE SPACE PER 150m² GROSS FLOOR AREA TOTAL BICYCLE SPACES REQUIRED = 7.4 (8) TOTAL CARSPACES PROVIDED = 8

R.P.D.
LOT NUMBER:
REG./SURVEY PLAN NO.:
PARISH:
COUNTY:

28 SP195007 MURCHISON LIVINGSTONE

ROCKHAMPTON REGIONAL COUNCIL APPROVED PLANS

These plans are approved subject to the current conditions of approval associated with

Development Permit No.: D/185-2023

Dated: 21 June 2024

Ε	DRAFT AMENDMENTS	12/06/24
D	MCU REVISION	24/04/24
С	GENERAL REVISION	08/11/23
В	PRELIMINARY LAYOUT	30/08/23
Α	PRELIMINARY LAYOUT	10/08/23
REV	DESCRIPTION	DATE

PROPOSED INDUSTRIAL PROJECT APEX FLEET SERVICES WADE STREET

PARKHURST

PH: 49 364 371 ez lifestyle HOMES

OVERALL SITE PLAN


CHKD : SCALE: As indicated Copyright © This plan or any portion thereof may not be reproduced without the express written permission of QFlair Pty Ltd QBCC 1131420

R.Q.


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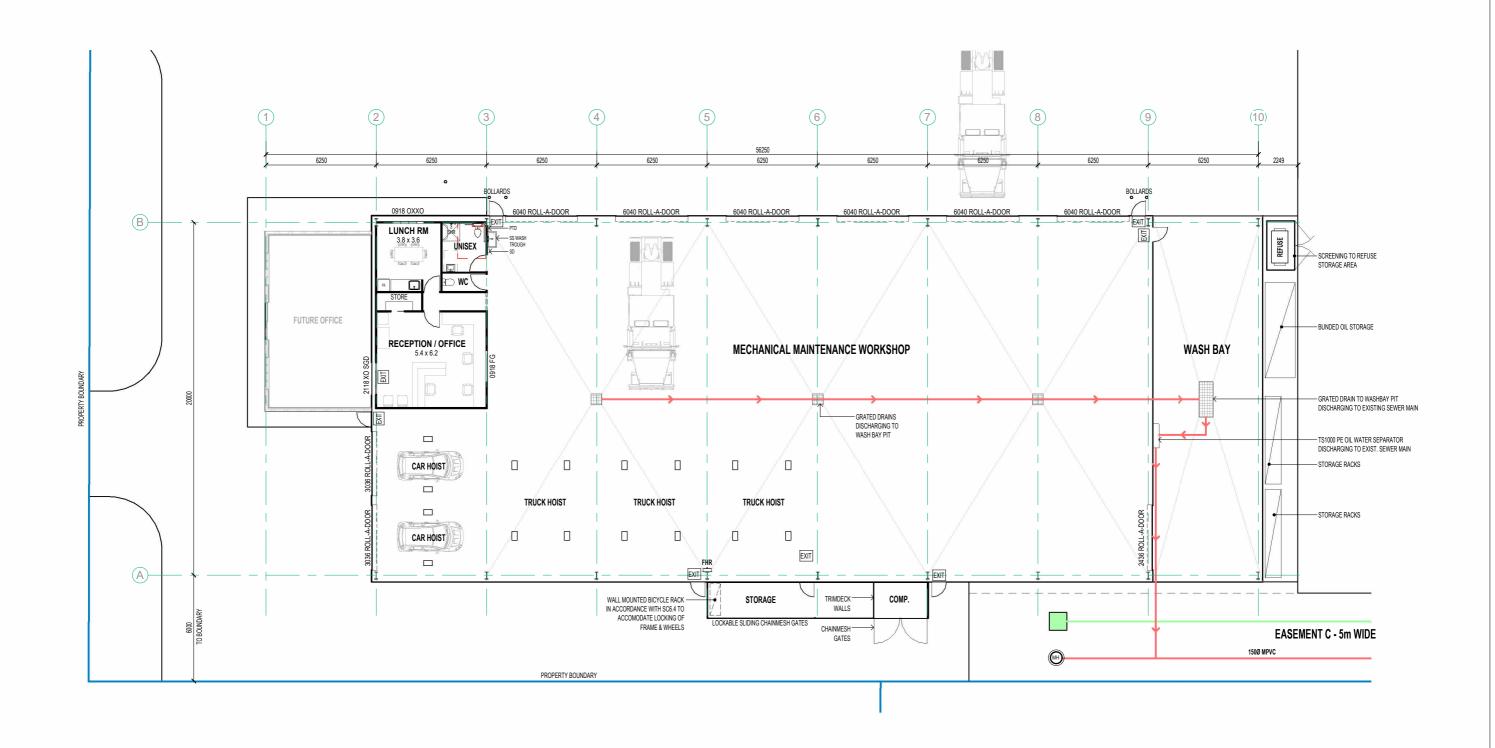
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Version: 1, Version Date: 12/06/2024



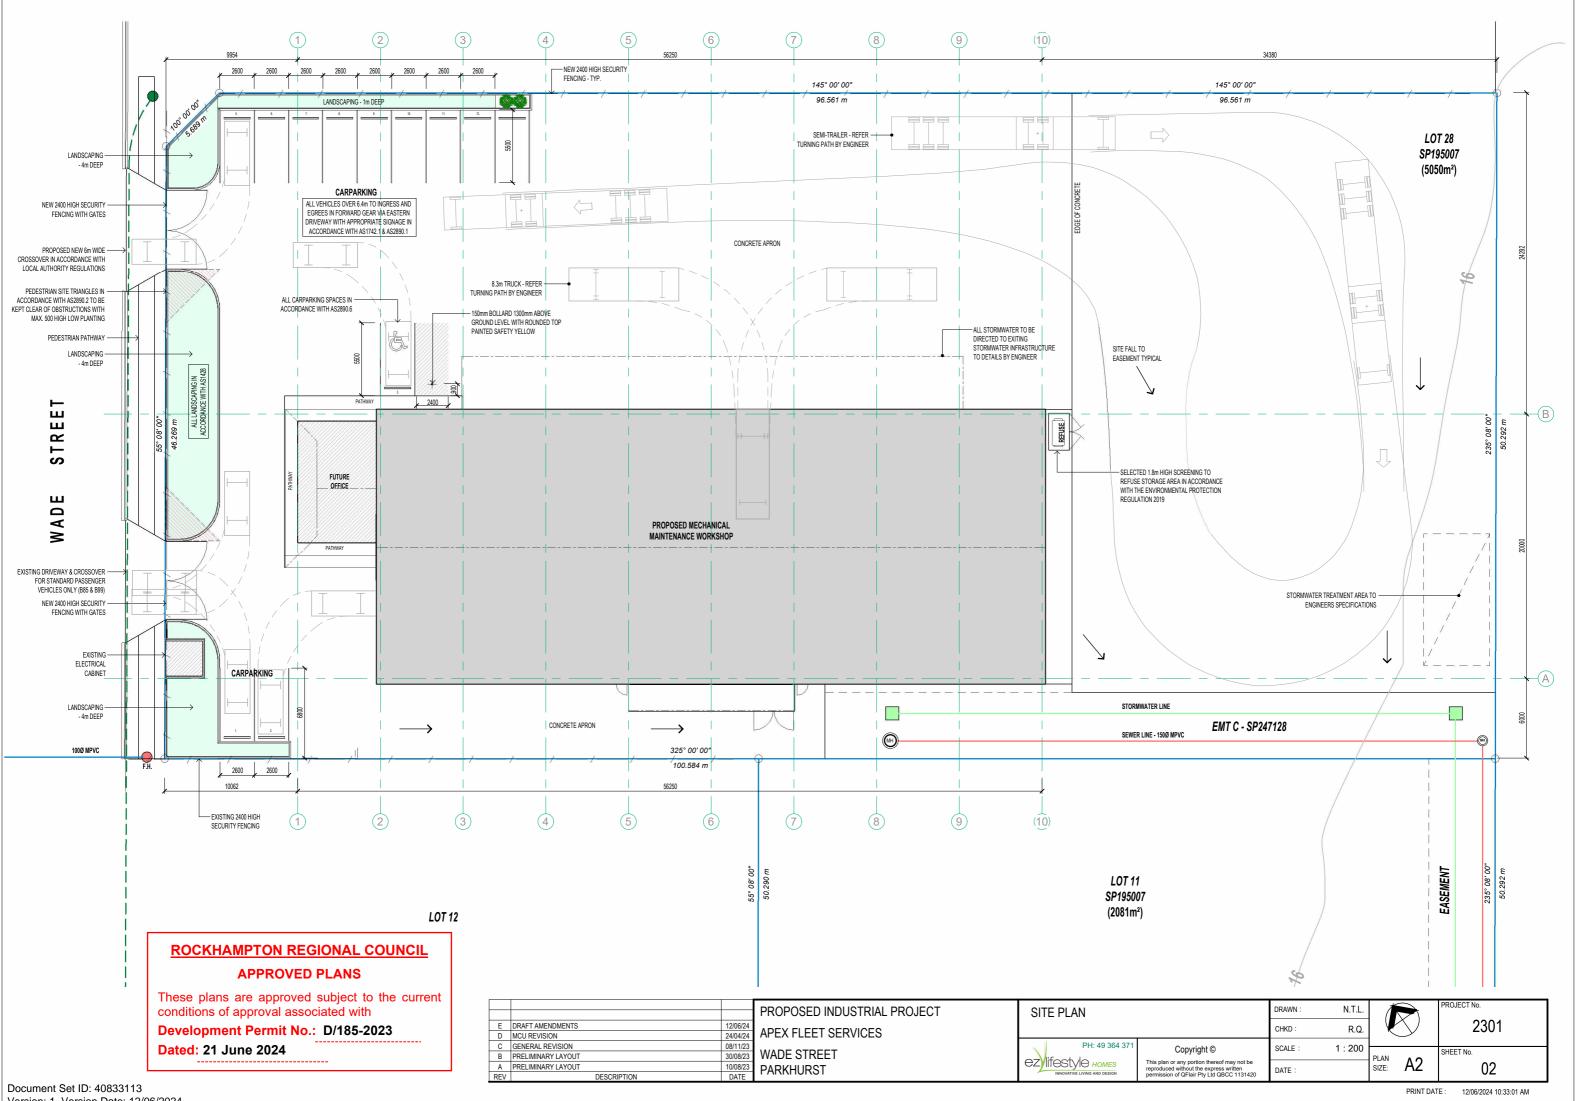

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Е	DRAFT AMENDMENTS	12/06/2
D	MCU REVISION	24/04/2
С	GENERAL REVISION	08/11/2
В	PRELIMINARY LAYOUT	30/08/2
Α	PRELIMINARY LAYOUT	10/08/2
REV	DESCRIPTION	DATE


PROPOSED INDUSTRIAL PROJECT
APEX FLEET SERVICES
WADE STREET
PARKHURST

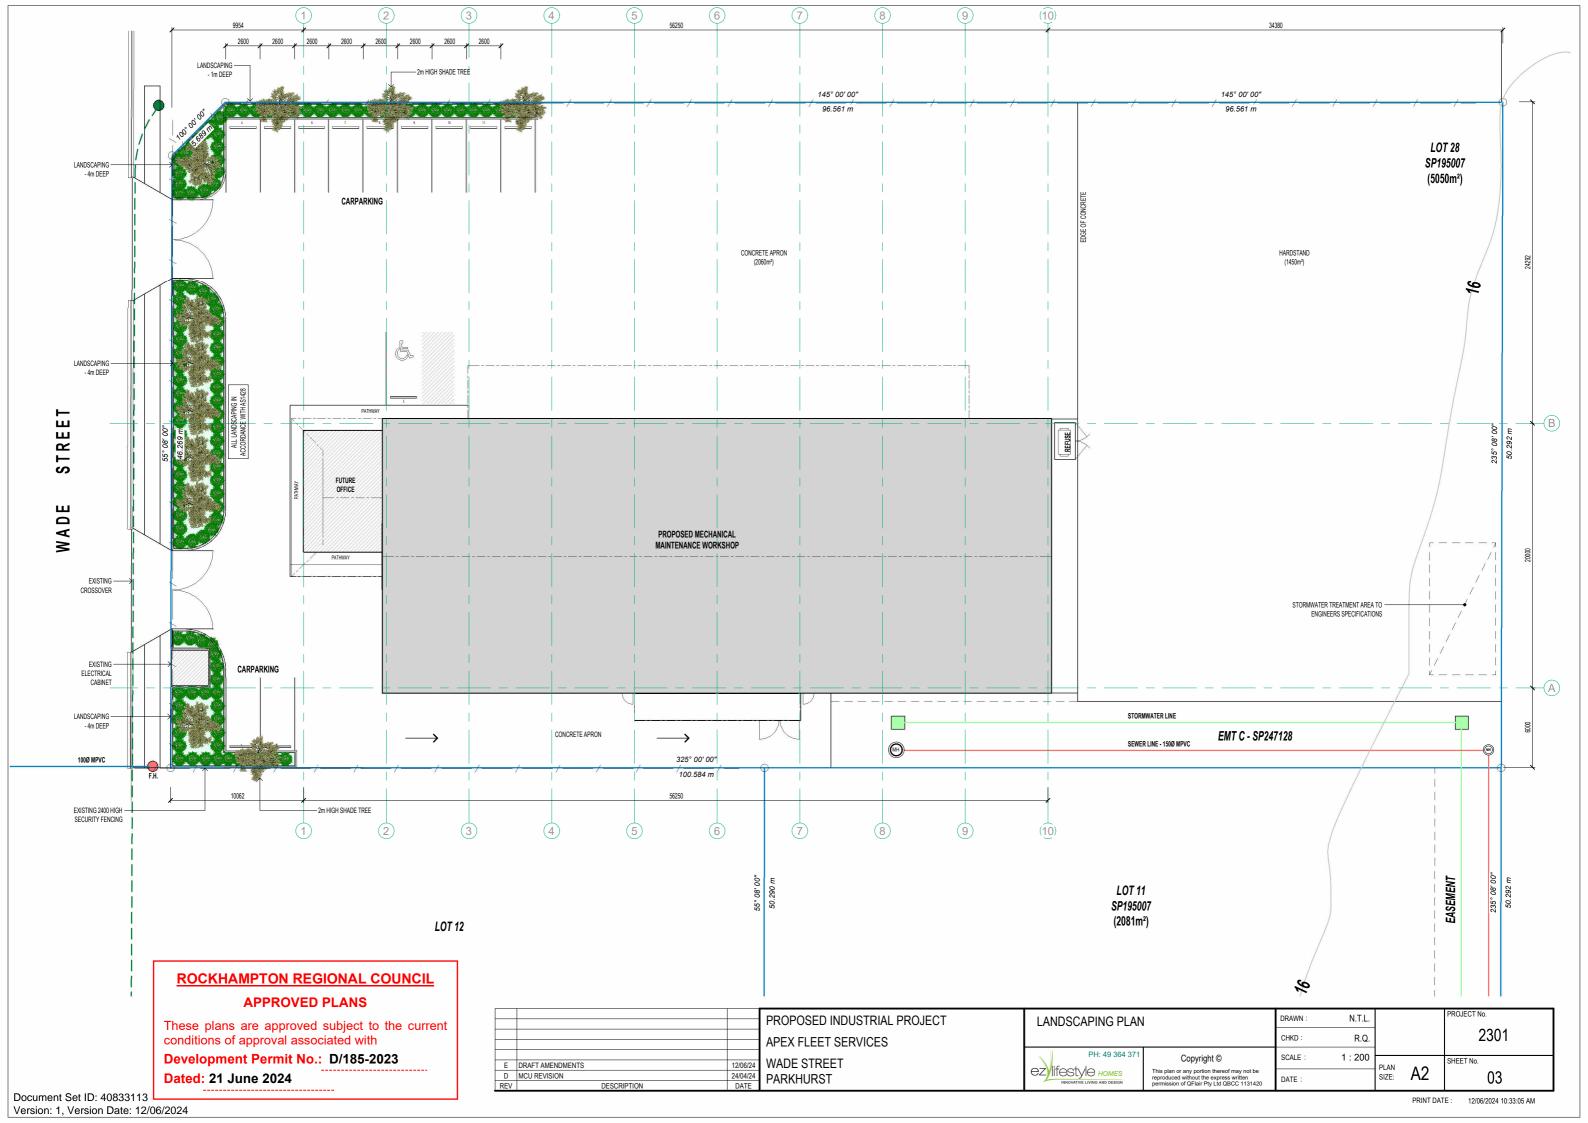FLOOR PLAN		DRAWN:	N.T.L.
		CHKD:	R.Q.
PH: 49 364 371	Copyright ©	SCALE :	1 : 150
EZVITESTAL HOMES INNOVATIVE LIVING AND DESIGN	This plan or any portion thereof may not be reproduced without the express written permission of QFlair Ptv Ltd QBCC 1131420	DATE :	

FLOOR AREAS		
61.1 m²		
71.6 m²		
129.9 m²		
849.2 m²		
1111.9 m²		

L.		PROJECT No.
Q.		2301
0	PLAN A O	SHEET No.
	SIZE: A2	04

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ROCKHAMPTON REGIONAL COUNCIL

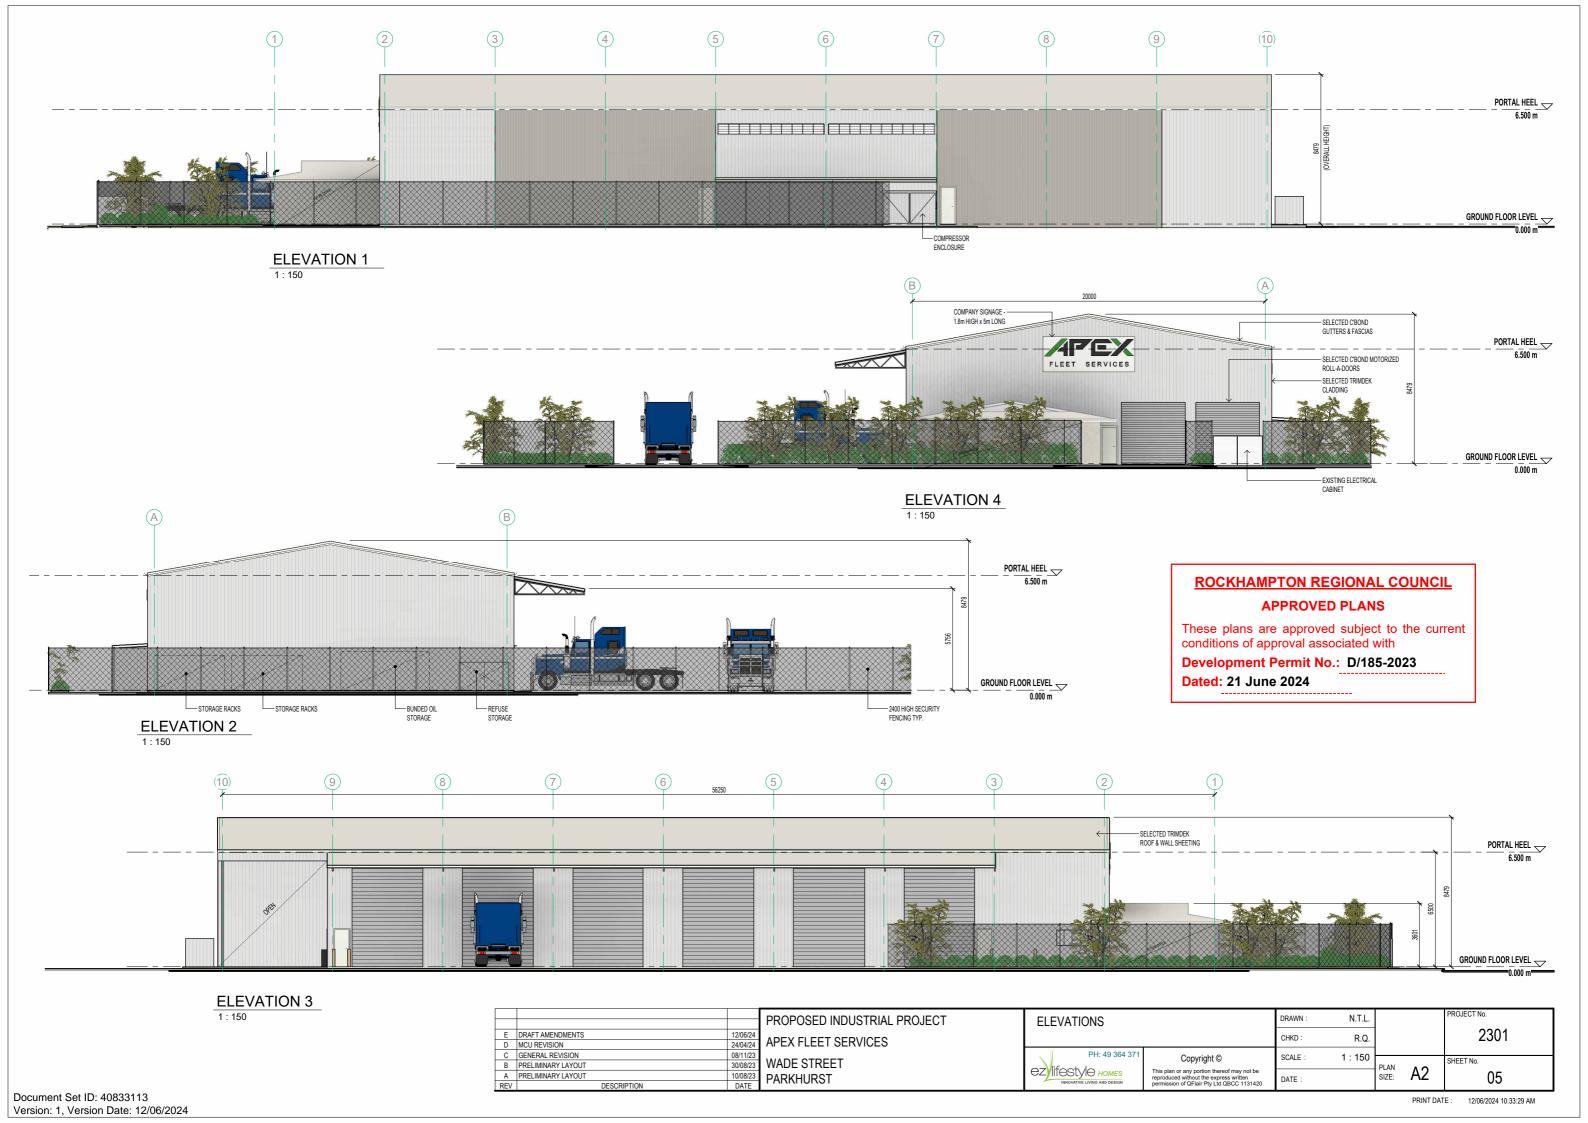APPROVED PLANS

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Dated: 21 June 2024

			PROPOSED INDUSTRIAL PROJECT	PERSPECTIVE VIEWS	S	DRAWN:	N.T.L.		PROJECT No.
E DRAFT AMEN D MCU REVISIO		12/06/24 24/04/24	APEX FLEET SERVICES			CHKD :	R.Q.		2301
C GENERAL RE	VISION	08/11/23 30/08/23	WADE STREET	PH: 49 364 371	Copyright ©	SCALE :		PLAN A O	SHEET No.
A PRELIMINAR		10/08/23 DATE	PARKHURST	EZVITESTAL HOMES INNOVATIVE LIVING AND DESIGN	This plan or any portion thereof may not be reproduced without the express written permission of QFlair Pty Ltd QBCC 1131420	DATE :		SIZE: A2	06

16.3-

WADE STREET

NOTE
THE DETAILS SHOWN ON THIS PLAN ARE PRELIMINARY & SUBJECT TO DETAIL DESIGN.

capricorn survey group (cq)
132 victoria parade, rockhampton
ph: 0749275199
email: reception@csgcq.com.au
DATUM MGA2020 ZONE 56;

HXGN SMARTNET CONTOURS 0.1m

ROCKHAMPTON REGIONAL COUNCIL

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- EXIST 375¢ ALLOTMENT STORM WATER DRAINAGE; SWALE DRAIN ABOVE

- GRATED INLET PIT (TYP)

EXISTING SITE TERRAIN DETAILS

EASEMENT

LOT 28 SP195007

PROPOSED BUILDING FOOTPRINT FSL16.6





PROPERTY DESCRIPTION:
LOT LOT 28 SP195007
COUNCIL REFERENCE:
D/185-2023



2402-CIV1

A3 SIZE

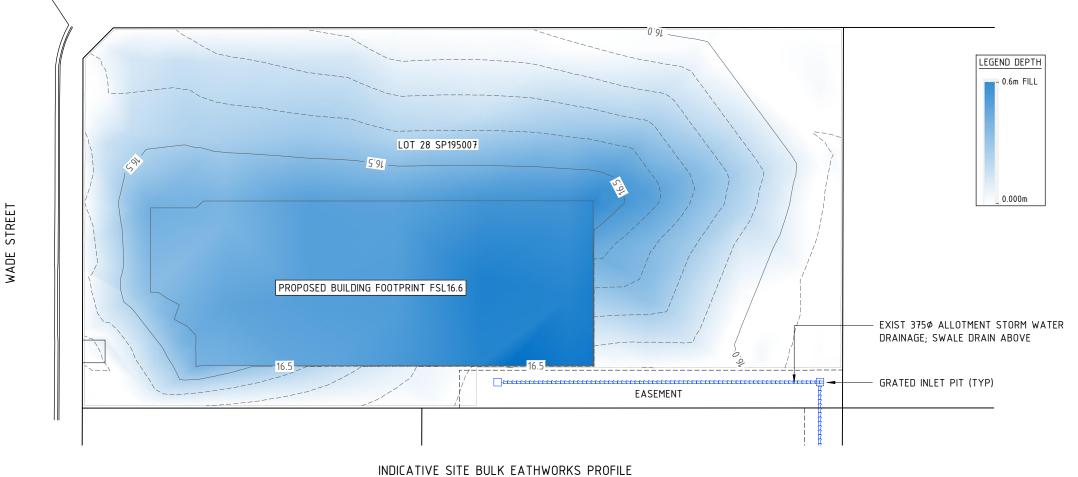

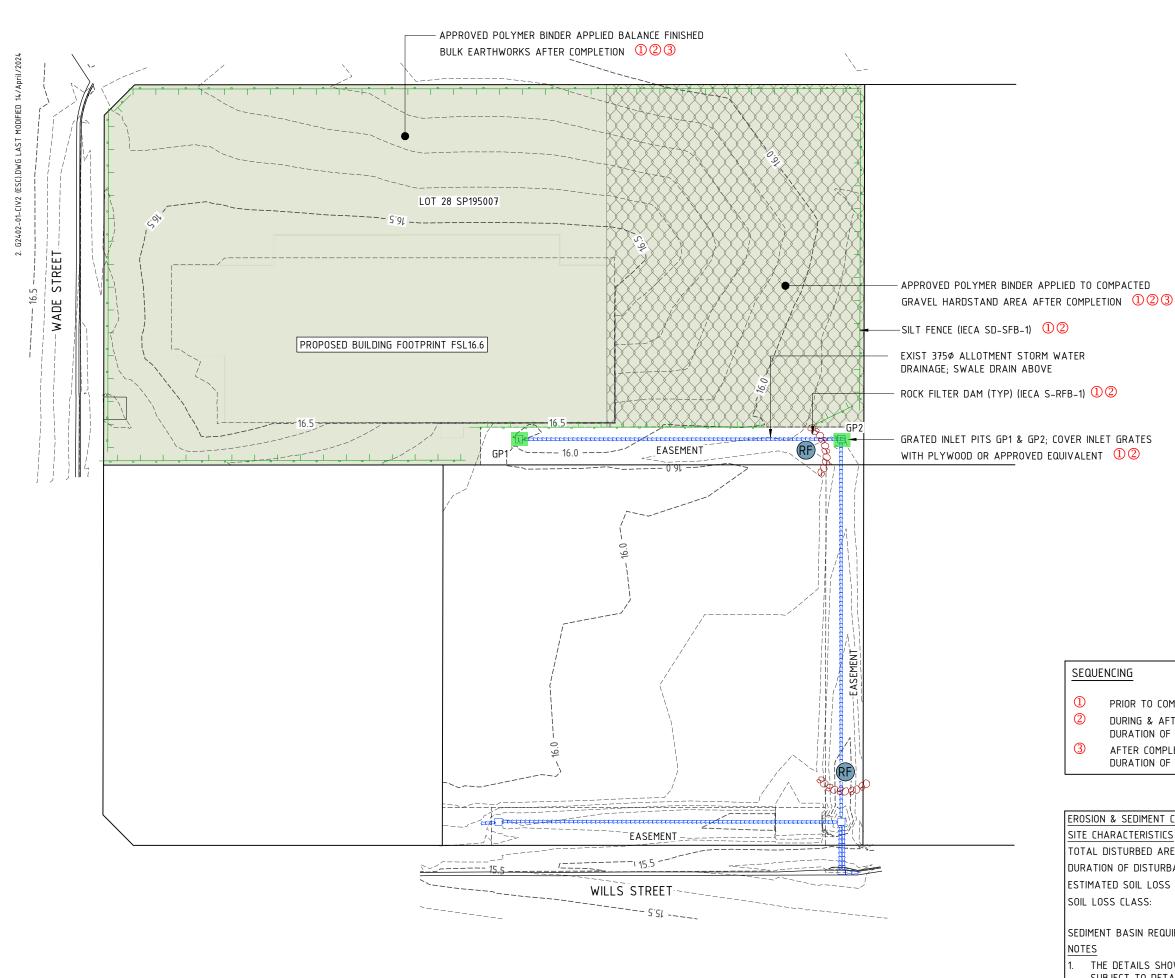

capricorn survey group (cq) 132 victoria parade, rockhampton ph: 0749275199

email: reception@csgcq.com.au

DATUM MGA2020 ZONE 56; HXGN SMARTNET CONTOURS 0.1m FIN. BULK EARTHWORKS

ROCKHAMPTON REGIONAL COUNCIL

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SEQUENCING

- PRIOR TO COMMENCEMENT OF EARTHWORKS
- DURING & AFTER COMPLETION OF EARTHWORKS & FOR DURATION OF CONSTRUCTION PERIOD
- AFTER COMPLETION OF CONSTRUCTION & FOR DURATION OF MAINTENANCE PERIOD

EROSION & SEDIMENT CONTROL MANAGEMENT - CONCEPT

SITE CHARACTERISTICS

TOTAL DISTURBED AREA:

DURATION OF DISTURBANCE: MAX 5 DAYS. FILLING ONLY. ESTIMATED SOIL LOSS (t/ha/yr): 30 (IECA GUIDELINES)

SOIL LOSS CLASS:

1; LOW RISK (IECA GUIDELINES)

NOTES

SEDIMENT BASIN REQUIRED: NO (IECA GUIDELINES)

THE DETAILS SHOWN ON THIS PLAN ARE PRELIMINARY & SUBJECT TO DETAIL DESIGN.

ALL ESC DEVICES TO BE INSTALLED AND MAINTAINED IN ACCORDANCE WITH IECA AUSTRALASIA BEST PRACTICE EROSION & SEDIMENT CONTROL MANUALS, IN PARTICULAR BOOKS 4 & 6.2.


PROPERTY DESCRIPTION: LOT LOT 28 SP195007 COUNCIL REFERENCE: D/185-2023

DATE 04/24 DATE 04/24 ACN 054 355 252 PH: 0417726918 email: adslu3d8@tpg.com.au REDRIDGE ENGINEERING GROUP APEX FLEET SERVICES INDUSTRIAL PROJECT WADE ST INFORMATION REQUEST RESPONSE CONSTRUCTION EROSION & & SEDIMENT CONTROL CONCEPT

G2402-01-CIV2.DWG G2402/1


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CleanaWater®

Industrial Water Treatment and Recycling Specialists

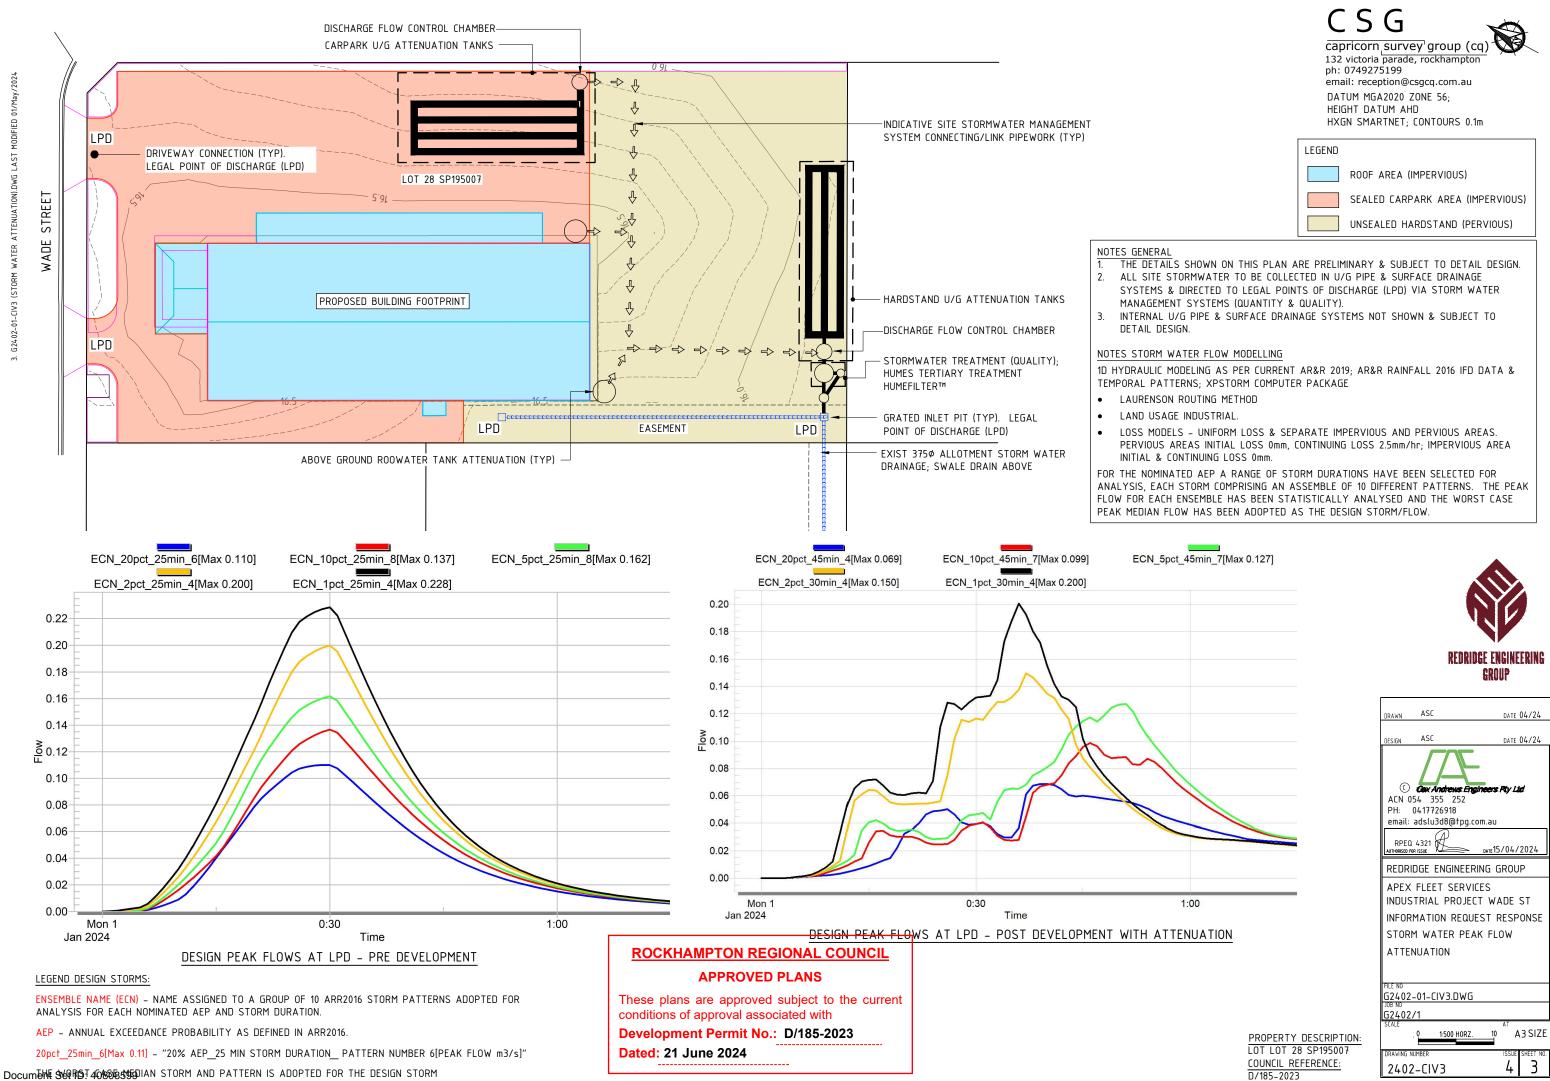TS1000 PE Oil Water Separator



ROCKHAMPTON REGIONAL COUNCIL
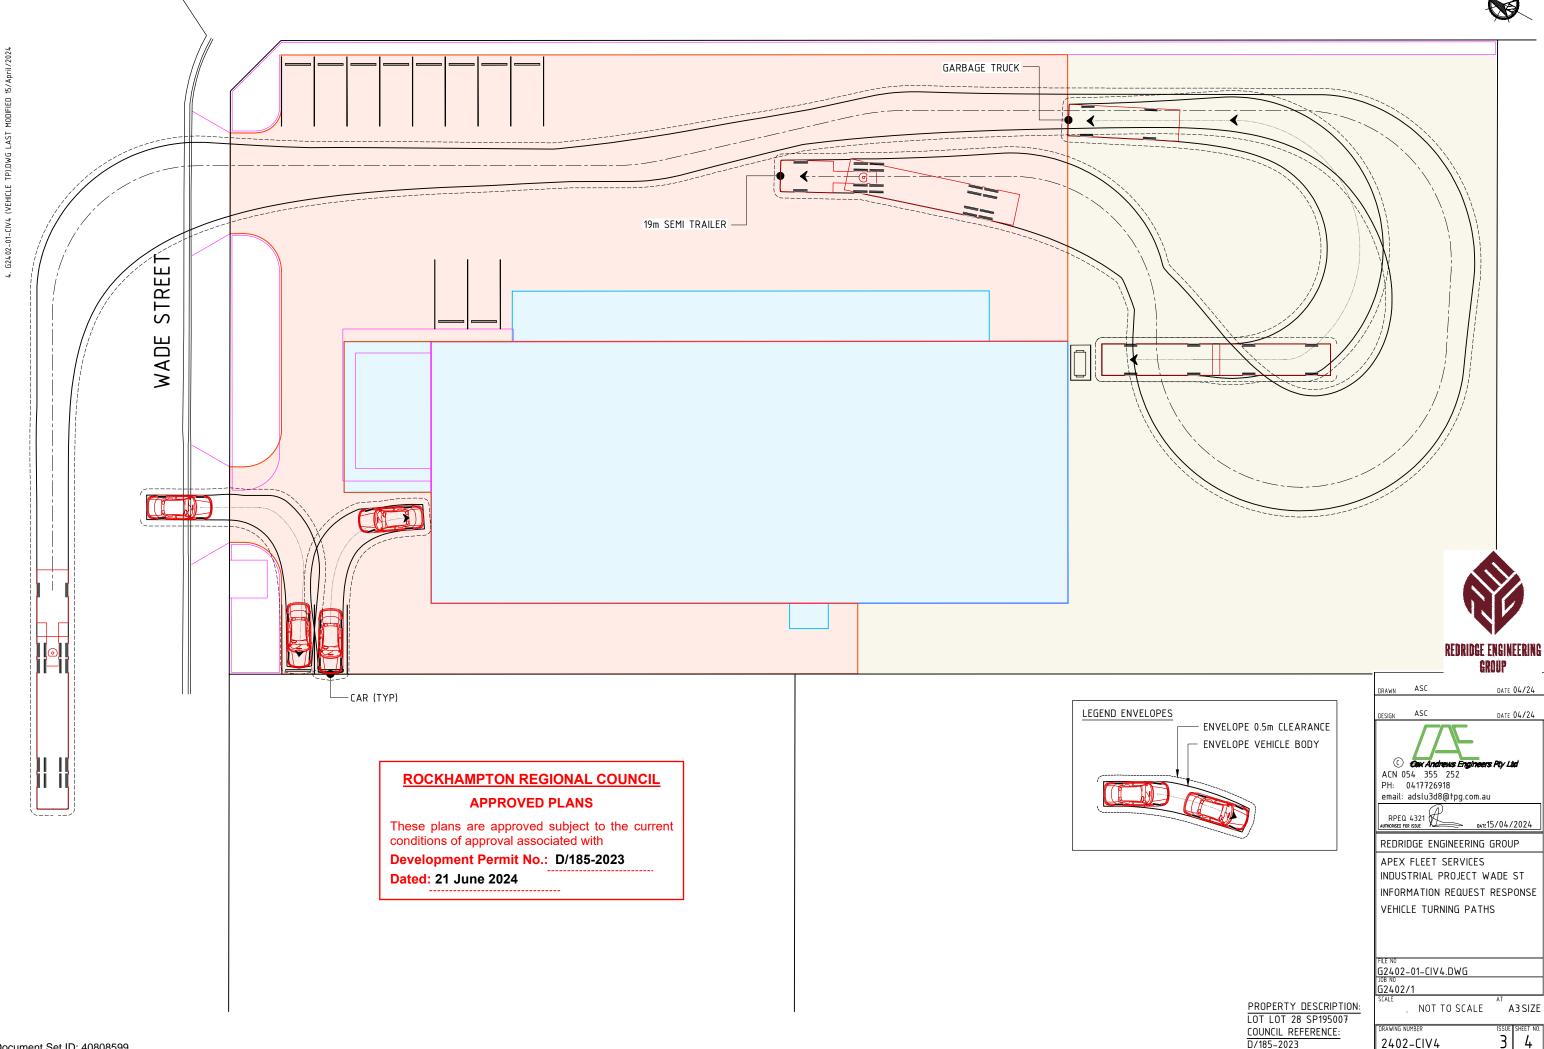
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Dated: 21 June 2024

1800 353 788 www.cleanawater.com.au





Why are they used?

CleanaWater's TS series oil water separator packages are installed to remove oils, grease and free hydrocarbons from waste water. They are a standard, low cost, pre-treatment system for industrial applications commonly used in Australasia.



Features

- Small footprint install to tight spaces
- Available with a selection of upgrades to suit site specific requirements
- Utilises MPK coalescing media technology which is less prone to premature blockage
- No filter bag consumables required
- Removes hydrocarbons to 3oppm to exceed water authority regulations
- Commonly used as primary treatment for water recycling

Benefits


- Approved and appraised by all major metropolitan and regional authorities
- Turn key packages easy and quick to install
- Avoid costly fines from authorities
- Avoid compromising the daily operations of your business
- Weatherproof for outdoor installation
- Automated operation and no consumables required
- Average working life of 20+ years




TS1000 PE Oil Water Separator

How do they work?

Coalescing media packs are positioned in two stages to force free oil droplets to collide with the surface of the media. Upon impact the droplets rise to the surface and are skimmed off into a waste oil container.

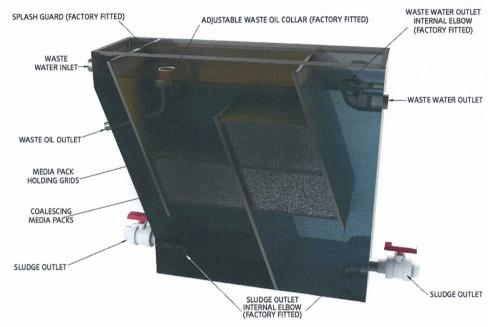

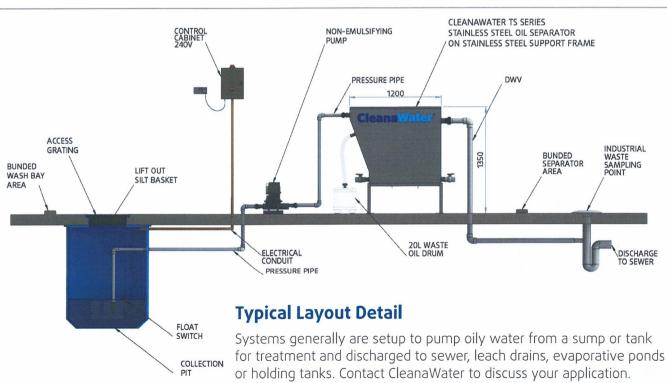



Common Applications

- Wash Down Bays
- Small to Large Industrial & Mechanical Workshops
- Mining Workshops
- Mining LV/HV Wash Down Bays
- Refuelling Areas
- Construction Sites
- Transformer Bunds

- Commercial Car Washes
- ♦ Vehicle & Equipment Wash Down Bays
- ♦ Truck & Heavy Vehicle Bays
- Service Stations
- AQIS Wash Down Facilities
- Hire Equipment Branches
- Food and Beverage Plants

Standard Inclusions List

Item	Standard		
CleanaWater Oil Water Separator			
Non-Emulsifying Pump			
Float Switch			
Control Panel 240V			
Stainless Steel Support Frame			
20 Litre Waste Oil Drum			



^{*}Additional accessories available to suit your specific application. Contact CleanaWater to discuss your requirements on 1800 353 788.





Specifications

Model	TS1000 PE				
System Info					
Dimensions	1349mm long x 360mm wide x 981mm high				
Nominal Litres per Hour	1,000 Litres per hour				
Maximum Litres per Hour	3,000 Litres per hour				
Material					
Construction	Polyethylene				
Shipping Weight/ Operating Weight	30kg / 380kg				
Pump Model	Diaphragm				
Power					
Power Requirement	240V 10 amp				
Power Usage	0.37kW				
Performance					
Typical TPH Influent	< 5000-6000ppm*				
Typical TPH Discharge (treated)	< 30ppm*				

^{*} TPH, oil and grease results are typical and based on free hydrocarbons only, emulsified hydrocarbons may affect discharge results and additional filtration may be required.