- PROPOSED OPTUS BASE STATION




LOCALITY MAP

ROCKHAMPTON REGIONAL COUNCIL APPROVED PLANS

These plans are approved subject to the current conditions of approval associated with

Development Permit No.: D/82-2023

Dated: 25 July 2024

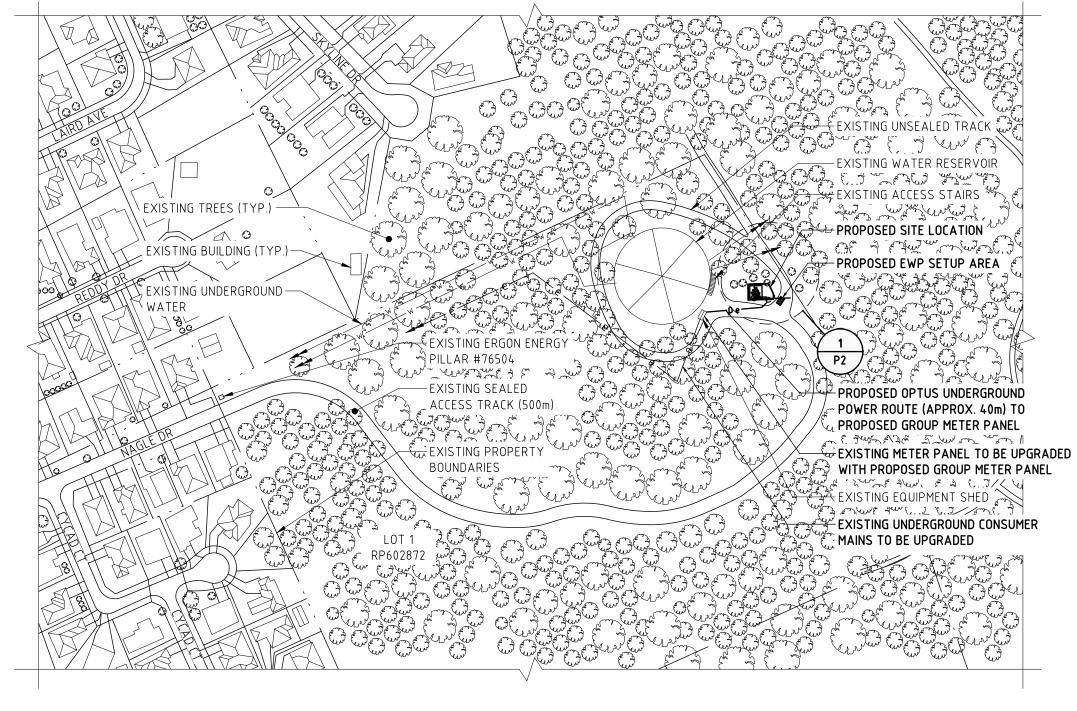

OVERALL SITE PLAN

SCALE 1:2000

						<u> </u>				
						i				
						!		_	_	
02	04.05.23	ISSUED FOR APPROVAL	KORDIA	SP	JW	i .	AS		BL	
01	28.06.22	ISSUED FOR APPROVAL	KORDIA	SP	JW	I	AS		MI	
Rev	Date	Revision Details	Consultant	CAD	Desig	ner	Verifier		Approver	

Ventia

Level 8, 80 Pacific Hwy, North Sydney, NSW 2060
www.ventia.com



MOBILE NETWORK
AUSTRALIA
SITE No:- B2621
NORMAN GARDENS EAST
50 NAGLE DRIVE


rawing ritie.	
DRAFT SITE	LAYOUT
SHEET 1 OF	2

FOR APPROVAL

Drawing No. **B2621-P1**

P1 02

D File: C:\Temp\B2621 - Norman Garden East - DSL if By: Milan Shakya Date: 05,05,23 3:58 PM

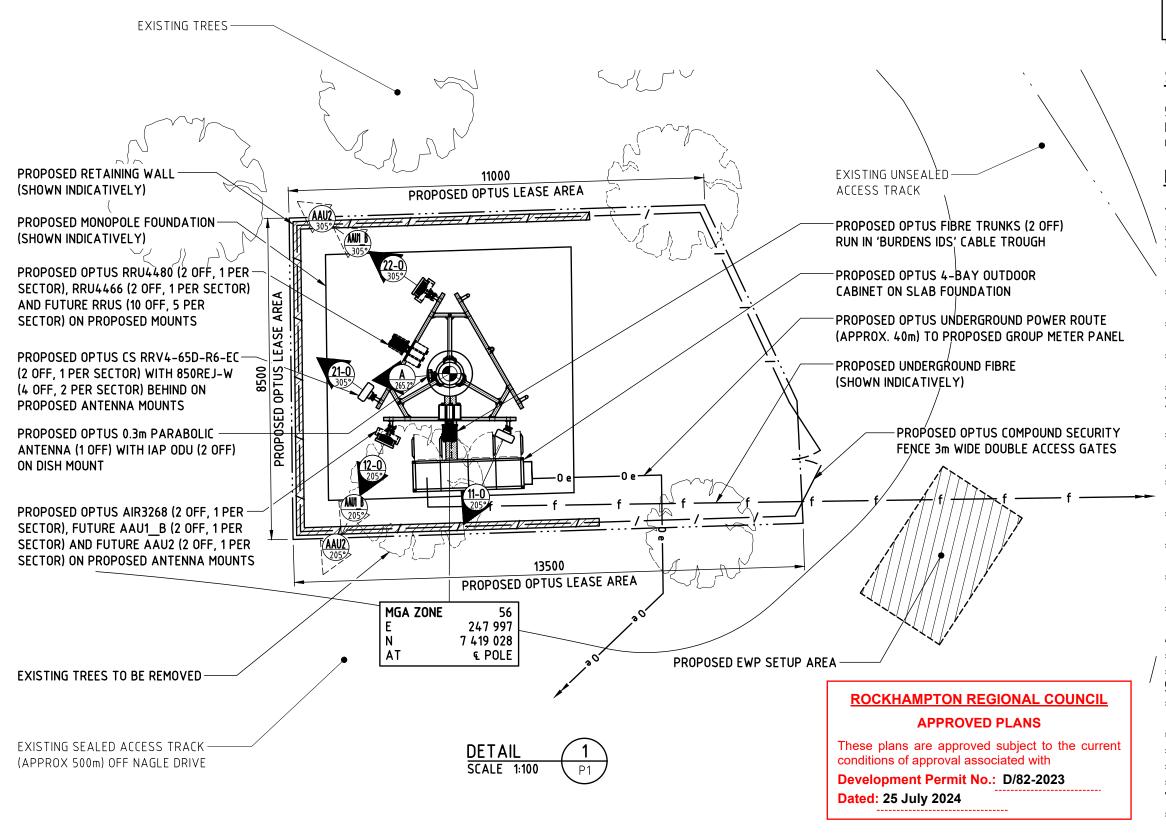

NOTES:

- 1. THIS DRAWING IS DIAGRAMMATIC ONLY AND SHOULD NOT BE SCALED.
- 2. DIMENSIONS, COORDINATES, AND LEVELS SHOWN ARE NOMINAL AND SUBJECT TO CONFIRMATION BY SURVEYOR.

SITE ADDRESS:

50 NAGLE DRIVE **NORMAN GARDENS** QLD 4701

NOTES:

- 1. BASIS OF DESIGN
- SITE INSPECTION ON 16/05/2022
- 2. PANEL ANTENNAS
- PROPOSED 1 OFF CS RRV4-65D-R6-EC 1 PER SECTOR (2 OFF TOTAL) AT EL 30.0m
- PROPOSED 1 OFF AIR3268 PER SECTOR (2 OFF TOTAL) AT EL 31.50m
- > FUTURE 1 OFF AAU1_B PER SECTOR (2 OFF TOTAL) AT EL 30.40m
- > FUTURE 1 OFF AAU2 PER SECTOR (2 OFF TOTAL) AT EL 28.90m
- MOUNTED ON PROPOSED TRIANGULAR HEADFRAME
- 3. TRANSMISSION
- > TRANSMISSION VIA PARABOLIC ANTENNA
- ONLY ONE RADIO LINK REQUIRED 5 RADIO B-ENDS **IDENTIFIED FROM DESPTOP**
- > PA LINK IN ORDER OF PREFERENCE
- > B2621 B0401 NEC 2 + 0 WITH IAP ODU, 0.3m ANTENNA AT 25m BEARING 265.2°
- > B2621_B1411 NEC 2 + 0 WITH IAP ODU, 0.6m ANTENNA AT 15m BEARING 277.56°
- > B2621 B8611 NEC 2 + 0 WITH IAP ODU, 0.6m ANTENNA AT 15m BEARING 181.48°
- > B2621 B0401 NEC 2 + 0 WITH IAP ODU, 0.6m ANTENNA AT 15m BEARING 211.08°
- B2621 B2621 NEC 2 + 0 WITH IAP ODU, 1.2m ANTENNA AT 15m BEARING 219.06°
- 4. EQUIPMENT SHELTER
- PROPOSED 4 BAY OPTUS OUTDOOR CABINET
- ON PROPOSED SLAB FOUNDATION
- OPTUS MONOPOLE
- PROPOSED OPTUS 30M HIGH MONOPOLE WITH TRIANGULAR HEADFRAME AT EL 30M
- 6. FEEDER CABLES
- > PROPOSED 2 OFF 9/18 MLEH ALL SECTORS
- > LENGTH: 40M ALL SECTORS
- PROPOSED SLAB MOUNTED CABLE LADDER
- 7. SITE ACCESS
- VIA EXISTING SEALED ACCESS TRACK (APPROX. 500M) OFF NAGLE DRIVE

8. ANTENNA ACCESS

ONLY BY QUALIFIED PERSONNEL VIA EWP/CHERRY DRAFT SITEKRAYOUT

SHEET 2 OF NDERGROUND (APPROX. 50M) FROM EXISTING

FOR APPROVAL

MOBILE NETWORK

AUSTRALIA

SITE No:- B2621 NORMAN GARDENS EAST

50 NAGLE DRIVE

OPTUS

B2621-P2 02

KORDIA SP JW |

02 04.05.23 ISSUED FOR APPROVAL 01 28.06.22 ISSUED FOR APPROVAL

